A TENANT IMPROVEMENT FOR:



VILLAGE LAKE RD. and SILVERLAKE PARK DR. ORANGE COUNTY, FLORIDA



LOCATION AERIAL PLAN

SCALE: NTS

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MECHANICAL, ELECTRICAL, PLUMBING

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CONTACT INFORMATION:

GENERAL CONTRACTOR:

SCHERER CONSTRUCTION OF CENTRAL FLORIDA, LLC 8014 VIA DELLAGIO WAY, #200 ORLANDO, FLORIDA 32819

MR. WES RADCLIFFE PH: 407-894-7661, X128

ENGINEER OF RECORDS

ROY A. BROWN, P.E. 1521 LISA DR. WACHULA, FL. 33873 PHONE: 863-687-4225 FL. REG. #11649

DESIGN FIRM:

CENTRAL FLORIDA DESIGNS, LLC 460 NIGHTHAWK DRIVE LAKELAND, FLORIDA 33813 PHONE: (863) 644-5818 FAX: (863) 644-7581 NORMAN GRINSTEAD, OWNER

UTILITY INFORMATION:

SEWER

ORANGE CO. UTILITIES DEVELOPMENT ENGINEERING DIVISION 9150 CURRY FORD ROAD, 2ND FL. ORLANDO, FL. 32825 PH: (407) 372-8477

WATER

ORANGE CO. UTILITIES
DEVELOPMENT ENGINEERING DIVISION 9150 CURRY FORD ROAD, 2ND FL. ORLANDO, FL. 32825 PH: (407) 372-8477

POWER





AAA GATOR ENGINEERING CA# 28430 PO BOX 1178 WACHULA, FL 33873



440 NESHTHAWK DRIVE, LAKELAND, FL 33813 PHONE: (843) 644-5692. GELL 863-398-5994 E-MAIL CENTRAL FLOREDA ERSEENBYGRIZONI CIVIL ENGINEERING & BUILDING DESE

201602

CALE: AS NOTED	
O1/XX/16	PLOT DATE: 01/XX/16
ESIGNED BY: NDG	

NDG FILE NAME: CHECKED BY: RB

SCHERER

FEB 1 2 2016

CONSTRUCTION & ENG

SCANNED

FEB 1 2 20%

COVER SHEET SHEET NO:

CENERAL PLAN NOTES:

1. THE CEMERAL CONTRACTOR (C.C.) SHALL FIELD VERBEY ALL POSSIBLE EXISTING CONDITIONS PRIOR TO CONSTRUCTION. C.C. SHALL IMMEDIATELY INFORM THE DESIGN PROFESSIONAL OF ANY CONFIDENCE WITH THE WORK PROPOSED IN THESE PLANS. C.C. SHALL IMMEDIATELY INFORM THE DESIGN PROFESSIONAL OF ANY DISCREPANCIES HE/SHE DISCOVERS WITH THESE PLANS.
2. DO NOT SCALE THESE DRAWINGS. LUSS FIGURED DIMENSIONS FOR NEW CONSTRUCTION. FIXTURES (LUGITS, ETC.) ARE NOT DIMENSIONED SO

2. DO NOT SCALE THESE DRAWNOS. "USE FIGURED DIMENSIONS FOR NEW CONSTRUCTION. FIXTURES (LIGHTS, ETC) ARE NOT DIMENSIONED SO THEY CAN BE COORDINATED WITH FURNITURE. AND INTERIOR DESIGNER.

3. IT IS THE G.C.'S RESPONSIBILITY THAT ALL CONSTRUCTION (AND DEMOLITION) IS TO PROCEED ONLY IN STRICT ACCORDANCE WITH ALL CONSTRUCTION (AND DEMOLITION).

4. THESE PLANS & SECONDATIONS SAND TO SELVE AND THE STRIPP OF THE G.C. TO COORDINATE SAND THE PROPERTY OF THE G.C. TO COORDINATE SAND THE SECONDATION OF THE G.C. TO COORDINATE WITH ALL PROPOSED WORK.

5. G.C. SHALL FIELD VERIFY ALL EXISTING UTILITY LINE LOCATIONS (INCLUDING TIE—IN ELEVATIONS). COORDINATE WITH ALL PROPOSED WORK.

6. G.C. SHALL FIELD VERIFY ALL EXISTING UTILITY LINE LOCATIONS (INCLUDING TIE—IN ELEVATIONS). COORDINATE WITH ALL PROPOSED WORK.

7. ANY PIPPING IN OPEN PLEUM CELING SHALL BE WRAPPED WITH 1 HOUR FIRE RATED TAPE.

8. G.C. TO COORDINATE MECHANICAL, PLUMBRIO & ELECTRICAL CONTRACTORS WITH SHELL CONTRACTOR TO VERIFY ALL SPACE REQUIREMENTS OF THE G.C. TO COORDINATE WITH ALL STANDARD AND PROPOSED AND THE GROWN OF THE GROWN

PRIOR TO SETTING OF STRUCTURAL ITEMS.

9, GC. TO COORDINATE THESE PLANS WITH ANY INTERIOR DESIGN PLANS INCLUDING SPECIAL WALL OR CEILING FINISHES, MOULDING OR WOODWORK, FIXTURES, BUILD—OUT & CABINETRY WHICH HAS INTERIOR DESIGNER & DESIGN PROFESSIONALS APPROVAL.

10, CC. SHALL BE RESPONSIBLE TO PROVIDE ALL MATERIALS AND LABOR AS INCESSARY TO CONSTRUCT THE FACULTY DEPICTED ON THESE PLANS. CONTRACTOR SHALL SECURE AND PAY FOR ALL NECESSARY PERMITS, LICENSES, INSPECTIONS AND ALL OTHER RECOURED FEES. THIS CONSTRUCTION SHALL BE CONSTRUCTION SHALL BE CONSTRUCTION SHALL BE CONSTRUCTION CL. SHALL LICEN OVER THE ALL THEN OF A CLEAN FACILITY, WITH A CERTIFICATION OF THE OWNER OF A CLEAN FACILITY, WITH A CERTIFICATION OF CONSTRUCTION C.C. SHALL TURN OVER TO THE OWNER OF ACLIANY FACILITY, WITH A CERTIFICATE OF OCCUPANCIES.

IN EFFECT AT THE TIME OF CONSTRUCTION, G.C. SHALL TURN OVER 170 THE OWNER A CLEAN FACULTY, WITH A CERTIFICATE OF OCCUPANCY, RECORD DOCUMENTS, INSPECTION CERTIFICATES, WARRANTES AND BONDS, EVIDENCE OF PAYMENT AND REASO F LIENS, AND OPERATION OF RECORD DOCUMENTS, RESPECTION CERTIFICATES, WARRANTES, AND BONDS, EVIDENCE OF PAYMENT AND REASO F LIENS, AND OPERATION OF RECORD THE AND ADMINISTRATION OF CONSTRUCTION GC. SHALL WILL THE FACULTY WITH THE OWNER AND DEMONSTRATE OPERATION OF RECORD THE ADMINISTRATION OF THE PAYMENT AND REASON. SHALL SHALL

COVER. Z. ALL ELECTRICAL CABINETS, FIRE EXTINGUISHERS, CABINETS AND OTHER RECESSED EQUIPMENT IN FIRE RATED WALLS SHALL BE BACKED TO WITH 5/8" TYPE X GYPSUM BOARD OR AS REQUIRED TO MAINTAIN THE RATING, PROVIDE DOUBLE STUDY OR BLOCKING AS REQUIRED TO MAINTAIN THE RATING, PROVIDE DOUBLE STUDY OR BLOCKING AS REQUIRED TO MAINTAIN THE RETARDANT TREATED, METAL STUDY AMY BE USED IN LIEU OF

WOOD BLOCKING.
28. ALL INTERIOR FINISH CLASSIFICATIONS SHALL BE TESTED AND BE CLASSIFIED IN ACCORDANCE WITH ASTM E84 AND THIER USE SHALL IN
ACCORDANCE WITH NFPA 101 — SECTION 10.2

DEMOLITION NOTES

NO DEMOLITION REQUIRED. THIS PROJECT IS ASSOCIATED WITH A NEW, GRASSROOTS CONSTRUCTION PROJECT. THESE PLANS ARE FOR THE INTERIOR TEMANT BUILD-OUT CONSTRUCTION ONLY. REFER TO THE CONSTRUCTION PLANS BY OTHERS FOR ALL STRUCTURAL BUILDING SHELL CONSTRUCTION AND ASSOCIALIES SITE CONSTRUCTION WORK INCLUDING PLUMBING POINTS OF CONNECTION.

SITE SPECIFIC NOTES

SCOPE OF WORK: A NEW EXERCISE FACILITY IS PROPOSED CONSISTING OF A EXERCISE AREAS, OFFICES, AND RESTROOMS

NOTE:

1. NA
2. G.C. SHALL SUBMIT SEPERATE FIRE ALARM AND FIRE SPRINKLER APPLICATION AND SHALL NOT BE PART OF THIS PERMIT IF APPLICABLE

. SEE DRAWING THIS PAGE FOR SPECIFIC USE OCCUPANCY COUNT CALCULATION — SIGN SHALL BE POSTED ALL EMERGENCY LIGHTING SHALL BE TIED TO LIGHTING CIRCUITS IN SAME ROOM OR AREA AND WIRED AHEAD OF SWITCHES — NO SEPERATE

WORK SHALL BE IN FULL COMPLIANCE 2014 FLORIDA FIRE PREVENTION CODE

56. ALL WORK SHALL BE IN FULL COMPLIANCE 2014 FLORIDA FIRE PREVENTION CODE
7. N/A
8. DUCT DETECTION SHALL BE PLACED ON SUPPLY SIDE OF ALL EXIST, AND PROP. A/C OF UNITS LARGER THAN 2000 CFM AND ACTIVATION OR
TROUBLE SHALL CAUSE A VISUAL AND AUDIBLE SHALLY OCCUPIED AREA
9. AFER THE INSTALLATION OF THE SPRINKLER SYSTEM — THE FANS SHALL BE LOCATED SO THAT THERE ARE NO CONFLICTS BETWEEN FAN
COMPRAGE AREA VS SPRINKLERS, SERINGLERS GOVERN.

CODE/ PROJECT | NFORMATI ON

PROPERTY ADDRESS:

VILLAGE LAKE RD. & SILVERLAKE PARK DR. WINDERMERE, FLORIDA ORANGE COUNTY

CODES: 1

2014 FLORIDA BUILDING CODE — 5th EDITION — BUILDING 2014 FLORIDA BUILDING CODE — 5th EDITION — EXISTING BUILDING 2021 FLORIDA BUILDING CODE — 5th EDITION — ACCESSIBILITY 2014 FLORIDA BUILDING CODE — 5th EDITION — ENERGY CONSERVATION 2014 FLORIDA BUILDING CODE — 5th EDITION — FUEL GAS 2014 FLORIDA BUILDING CODE — 5th EDITION — FUEL GAS 2014 FLORIDA BUILDING CODE — 5th EDITION — PLUMBING 2014 FLORIDA BUILDING CODE — 5th EDITION — PLUMBING 2014 FLORIDA FIRE PREVENTION CODE 5th EDITION — PLUMBING 2014 FLORIDA FIRE PREVENTION CODE 5th EDITION — EDITION 2014 FLORIDA FIRE PREVENTION CODE 5th EDITION — EDITION 2014 FLORIDA FIRE PREVENTION CODE 5th EDITION — EDITION 2014 FLORIDA FIRE PREVENTION CODE 5th EDITION — EDITION 2014 FLORIDA FIRE PREVENTION CODE 5th EDITION 2014 FLORIDA FIRE PREVENTION 2014 FLORIDA FIRE PR

BUILDING INFORMATION:	
BUILDING CRITERIA	CODE PROVISION
1. SITE REQUIREMENTS	N/A
2. PROPOSED OCCUPANCY USE	GROUP A3 - ASSEMBLY
3. TYPE OF CONSTRUCTION	TYPE 3 - PROTECTED
4. ALLOWABLE BUILDING HEIGHT	EXISTING ONE STORY
5. NUMBER OF STORIES	1-STORY EXISTING
6. GROSS LEASE AREA	9657 GROSS S.F. 1st FLOOR 11292 GROSS S.F. TOTAL

7 FIRE RESISTANT CONSTR REQ. N/A 8. FIRE SUPPRESSION SYSTEMS N/A

9. OCCUPANCY SEPERATION REQ. N/A 10 OCCUPANT LOAD 216 - SEE DRAWING BELOW

11. NUMBER OF EXITS PROVIDED 4 PROVIDED 12 MAXIMUM ALLOWARIE DEAD END 20'-0" 200'-0' 13. MAXIMUM TRAVEL DISTANCE

15. MINIMUM EXIT AISLE / CORRIDOR WIDTH 44" 16. MINIMUM CLEAR OPENING @ EXIT DOOR 32" PER FBC 1008.1.1

17. MINIMUM INTERIOR FINISH CLASSIFICATION (NEPA)

LOCATION CLASS A (IF OCCUPANCY IS < 300)

EXIT ACCESS CORRIDORS A OR B OTHER SPACES A. B OR C

18. PLUMBING FIXTURE COUNT/REQ. 216 OCCUPANTS 19. MINIMUM INTERIOR WALL & CEILING FINISH REQ. BY OCCUPANCY (FBC)

LOCATION (EXITS AND EXIT ACCESS CORRIDORS PER FBC TBL 803.9) OCCUPANCY

EXIT ENCLOSURES AND EXIT PASSAGEWAY A3 -SPRINKLERED CORRIDORS

FIRE DOOR CAPACITY (NOT OCC. CALC)

SEE NOTE #4 - SITE SPECIFIC NOTES DOOR # 1 (72" DOUBLE DOOR)

68"/0.2 = 340 OCCUPANTS DOOR # 2 (72" DOUBLE DOOR)

68"/0.2 = 340 OCCUPANTS DOOR # 3 (36" SINGLE DOOR)

34"/0.2 = 170 OCCUPANTS DOOR # 4 (36" SINGLE DOOR)

FIRE CAPACITY = 1020 OCCUPANTS (NOT OCC. CALC) NEW CAPACITY = 216 OCCUPANTS (PROPOSED) PASS

34"/0.2 = 170 OCCUPANTS

PER F.A.C. 61G15-32.003 THE FIRE SPRINKLER PERMIT SHALL BE BY OTHERS FOR ANY MODIFICATION TO THE EXISTING SPRINKLER SYSTEM. THIS OFFICE HAS PREFORMED A STUDY REGARDING THE MODIFICATION OF THE FIRE SPRINKLER SYSTEM AND DETERMINED THAT THE COST FOR MODIFICATION TO THE EXISTING SPRKINLER SYSTEM WILL BE LESS THAN \$5,000 AND WILL NOT MODIFY THE EXISTING NUMBER OF HEADS.


MEATHOD OF COMPLIANCE SHALL CONFORM WITH THE <u>WORK AREA COMPLIANCE MEATHOD</u>
PER THE PROVISIONS OF THE 2014 FBC — EXISTING BUILDING CODE SECTION 101.5.2
REPAIRS, ALTERATIONS, ADDITIONS, CHANGES IN OCCUPANCY AND RELOCATED BUILDING
COMPLYING WITH THE APPLICABLE REQUIREMENTS OF CHAPTERS 4 THROUGH 12 OF THIS CODE SHALL BE CONSIDERED IN COMPLIANCE WITH THE PROVISIONS OF THIS CODE.

> CHANGE OF OCCUPANCY FROM GROUP M TO GROUP A THE CHANGE OF OCCUPANCY SHALL BE IN COMPLIANCE WITH FBC CHAPTER 9

PLUMBING FIXTURE COUNT

	DRINKING FOUNTAIN	W.C. REQUIREMENTS	LAV REQUIREMENTS	SERVICE SINK
REQUIRED 1	1 PER 500	MEN 1 WC PER 125	1 LAV PER 200	1 REQUIRED
	I FER 300	WOMEN 1 WC PER 65	1 LAV PER 200	I REQUIRED

DRINKING FOUNTAIN WC REQUIRED WC PROWDED LAV PROVIDED SERVICE SINK 108/125 = 0.86 MFN PROVIDED WOMEN 108/65 = 1.66

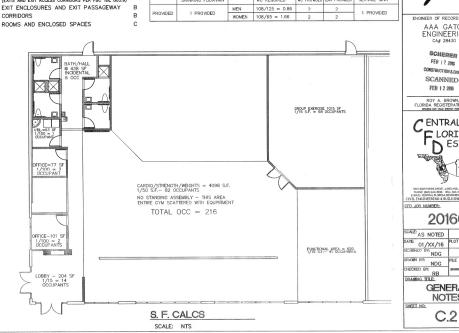

CLIENT: CAM AM VENTURES

> 9418 PRINCE HARRY DR. ORLANDO, FL 32836 PH: 407-284-7979





AAA GATOR ENGINEERING CA# 28430

FEB 1 2 2016 CONSTRUCTION & ENG. SCANNED

ROY A. BROWN, P.E. FLORIDA REGISTERATION #11649





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01/XX/16 **GENERAL**

NOTES



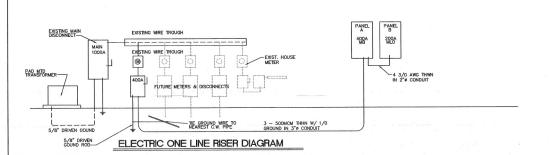

EL	ECTRIC SYMBOL LEGEND
SYMBOL	DESCRIPTION
\$	20A, 120V, SINGLE POLE LIGHT SWITCH, MOUNT CENTER AT 48" AFF
\$,	20A, 120V, THREE-WAY LIGHT SWITCH, MOUNT CENTER AT 48" AFF
\$4	20A, 120V, FOUR-WAY LIGHT SWITCH, MOUNT CENTER AT 48" AFF
\$u	20A, 120V, MOTOR RATED SWITCH, MOUNT ADJACENT TO EQUIPMENT TO BE CONTROLLED. VERIFY AMPACITY WITH EQUIPMENT NAMEPLATE.
ф	20A, 120V, SINGLE DEDICATED RECEPTACLE, MOUNT AT 18" AFF
4	20A, 120V, DUPLEX RECEPTACLE, WALL MOUNT AT 18" AFF
-	20A, 120V, DUPLEX RECEPTACLE, WALL MOUNT AT 4" ABOVE COUNTER, COORDINATE WITH MILWO
4	20A, 120V, GFI DUPLEX RECEPTACLE, WALL MOUNT CENTER AT 18" AFF
4	20A, 120V, GFI DUPLEX RECEPTACLE, WALL MOUNT AT 4" ABOVE COUNTER BACKSPLASH.
4	20A, 120V, HALF SWITCH DUPLEX RECEPTACLE, WALL MOUNT CENTER AT 18" AFF
4	20A, 120V, DUPLEX RECEPTACLE FOR MICROWAVE, MOUNT CENTER AT 72" AFF
(20A, 120V, DUPLEX RECEPTACLE, RECESS FLOOR MOUNTED, PROVIDE BRASS COVER PLATE AND CARPET FLANGE.
0	20A, 120V, DUPLEX RECEPTACLE, CEILING MOUNTED
4	20A, 120V, QUADDRUPLEX RECEPTACLE, WALL MOUNT AT 18" AFF
	20A, 120V, QUADDRUPLEX RECEPTACLE, RECESS FLOOR MOUNTED. PROVIDE BRASS COVER PLATE AND CARPET FLANCE.
(4)	SPECIAL PURPOSE RECEPTACLE. VERIFY EXACT TYPE WITH CONTRACTOR/EQUIPMENT NAMEPLATE.
(JB)	JUNCTION BOX
- ▽	TELEPHONE CUTLET. WALL MOUNT AT 18" AFF. PROVIDE 3/4" CONDUIT WITH PULLSTRING TO 6" ABOVE CELING. USE 1" CONDUIT FOR THOSE DENOTED WITH A "2"
4	TELEPHONE OUTLET. WALL MOUNT AT 4" ABOVE COUNTER, COORDINATE WITH MILLWORK. PROVID 3/4" CONDUIT WITH PULLSTRING TO 6" ABOVE CELLING. USE 1" CONDUIT FOR THOSE DENOTED WITH A "2"
SYMBOL	DESCRIPTION
•	DATA CUTLET. WALL MOUNT AT 18" AFF PROVIDE 3/4" CONDUIT WITH PULLSTRING TO 6" ABOVE CEILING. USE 1" CONDUIT FOR THOSE DENOTED WITH A "2"
4	TELEPHONE DATA OUTLET. WALL MOUNT AT 18" AFF PROVIDE 3/4" CONDUIT WITH PULLSTRING TO 6" ABOVE CEILING, USE 1" CONDUIT FOR THOSE DENOTED WITH A "2"
[7]	TELEPHONE OUTLET. RECESS FLOOR MOUNTED. PROVIDE 3/4" CONDUIT WITH PULLSTRICG TO

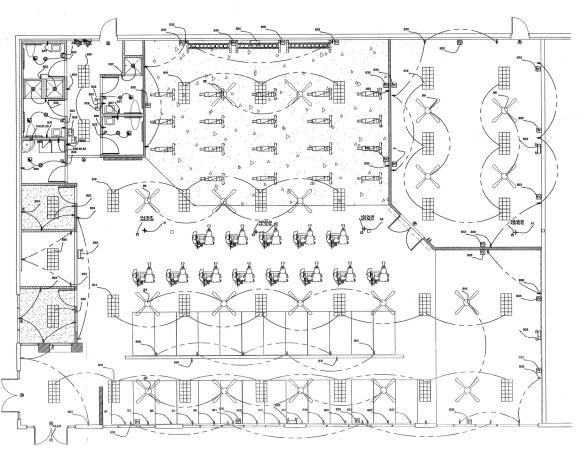SYMBOL	DESCRIPTION
▼	DATA OUTLET. WALL MOUNT AT 18" AFF PROVIDE 3/4" CONDUIT WITH PULLSTRING TO 6" ABOVE CEILING, USE 1" CONDUIT FOR THOSE DENOTED WITH A "2"
4	TELEPHONE/DATA OUTLET. WALL MOUNT AT 18" AFF PROVIDE 3/4" CONDUIT WITH PULLSTRING TO 6" ABOVE CEILING. USE 1" CONDUIT FOR THOSE DENOTED WITH A "2"
▽	TELEPHONE OUTLET. RECESS FLOOR MOUNTED. PROVIDE 3/4" CONDUIT WITH PULLSTRICG TO NEAREST WALL AND THEN 6" AROVE CEILING USE 1" CONDUIT FOR THOSE DENOTED WITH A "2"
4	TELEPHONE/DATA OUTLET, RECESS FLOOR MOUNTED, PROVIDE 3/4" CONDUIT WITH PULLSTRICG TO NEAREST WALL AND THEN 6" ABOVE CEILLING, USE 1" CONDUIT FOR THOSE DENOTED WITH A "2"
▼	DATA OUTLET, RECESS FLOOR MOUNTED, PROVIDE 3/4" CONDUIT WITH PULLSTRICG TO NEAREST WALL AND THEN 6" ABOVE CEILLING, USE 1" CONDUIT FOR THOSE DENOTED WITH A "2"
TV	TELEVISION OUTLET: MOUNT AT 12'-0" AFF W/CABLE CONNECTION OUTLET
	ELECTRICAL PANEL
	TRANSFORMER
-₩- w□'	DISCONNECT SAFETY SWITCH (3) POLES, 30A FRAME. ** DENOTES CONTRACTOR TO PROVIDE FUSES PER MANUFACTURERS NAMEPLATE, UNLESS NOTED OTHERWISE. "NF" DENTES NOT FUSED.
⊠	FACTORY MOUNTED DISCONNECT.
os	OCCUPANCY SENSOR AT SWITCH
© 0	CLOCK/INTERCOM SYSTEM
● EPO	EMERGENCY POWER OFF SWITCH
WP	WEATHER PROOF
GFI	GOUND FAULT CIRCUIT INTERRUPTER
AFF	ABOVE FINISHED FLOOR
AFG	ABOVE FINISHED GRADE
⊗	ONE WAY EXIT SIGN BATTERY BACKUP - WIRE AHEAD OF LIGHTS
к	KNOX BOX
⑤	SMOKE DETECTOR
①,	HEAT DETECTOR
P	EMERGENCY LIGHTS W/BATTERY BACKUP - WIRE AHEAD OF LIGHTS

SITE SPECIFIC NOTES:

- EACH EMERGENCY LIGHT SHALL BE TIED TO LIGHTING CURCUIT IN SAME ROOM OR AREA AS LOCATION OF FIXTURE PER NEC-700-12
- SMOKE DETECTOR, 120V WITH BATTERY BACK-UP, HARD WIRED TO BATHROOM LIGHTING CURCUIT. INTERCONNECT FOR SIMULTANEOUS OPERATION. MOUNT AT LEAST 3' FROM A/C SUPPLY GRILL.
- OFFICIAL ME OFFICE IS TURNED FOW ON THE THANT SPACE THE OFFICE IS TURNED FOW ON THE THANT SPACE THE OFFICE IS THAN THE OFFICE IS THAN THE DESIGNED OF THE ACTUAL POWER USAGE FOR EACH PAREL. ANY NEW EXPRESS FOR THAN THE OFFICE IS THAN THE OFFICE IS THAN THE OFFICE IS TH

CAM AM VENTURES INTERNATIONAL, INC. 9418 PRINCE HARRY DR. ORLANDO, FL 32836 PH: 407-284-7979



AAA GATOR ENGINEERING CA# 28430

> SCHERER FEB 12 273

CONSTRUCTION & ENG.

SCANNED FEB 1 2 2016



IL ENGINEERING & BUILDING DESIGN

201602

SCALE: AS NOTED DATE: 01/XX/16
DESIGNED BY: NDC DATE: 01/XX/16 DRAWN BY: NDG
CHECKED BY: RB
DRAWNG TITLE:

ELECTRICAL **PLAN**

SHEET NO:

E.1

ELECTRICAL PLAN

SCALE: 3/16" = 1'-0"

ELECTRICAL GENERAL NOTES:

- THE WORK SHALL COMPLY WITH THE LATEST APPLICABLE REQUIREMENTS OF THE NATIONAL ELECTRICAL CODE, FLORIDA BUILDING CODE AND ALL OTHER LOCAL CODES AND ORDINANCES GOVERNING THIS INSTALLATION. AS A MINIMUM STANDARD, UNLESS SPECIFICATIONS LISTED. HERBIN OR SHOWN OR PLANS REQUIRE A HOHER STANDARD, COUPLED ON STANDARD, UNLESS SPECIFICATIONS THE WORK INCLUDED CONSISTS OF ALL SUPERVISION, LABOR, MATERIALS, COUPLED FAULTH SALD THAT OF THE COMPLETE STATISTACTORY AND APPROVED ELECTRICAL SYSTEMS AS INJUICATED OR THE DRAWINGS AND CALLED FOR IT THIS SPECIFICATION, OR AS MAY BE REASONALLY MAPLED BY ETHER.

- OR AS MAY SE REASONABLY MAPLED BY STINER.

 3. ALL NOTES ON THE DRAWINGS PERTAINING TO THE WORK OF THIS TRADE SHALL BE CONSIDERED AS PART OF THIS SPECIFICATIONS AND CONTRACT.

 C

- TRADES MILL PERMIT.

 IR RECEPTACES SHALL BE 20A, 1250V, 2 POLE, 3 WIRE SHINGLE OR DUPLEX GROUND TYPE EXCEPT WHERE SPECIFIC PURPOSE, LOCKING OR HIGHER RATED RECEPTACLES ARE SHOWN ON THE ORNAMOS.

 IT WALL SWITCHES SHALL BE OF THE TOTALLY ENCLOSED TUMBLER TYPE WITH BODIES OF PHENOLIC COMPOUND. HANDLES SHALL BE WHITE
- 18. CONTRACTOR SHALL VERIFY ALL EQUIPMENT NAMEPLATE DATA FOR WIRING AND OVER CURRENT PROTECTION REQUIREMENTS BEFORE

- 17. WALL SWITCHES SHALL BE OF THE TOTALLY ENCLOSED TUMBLER TYPE WITH BOOLES OF PHENOLOC COMPOUND. HANDLES SHALL BE WHITE COLORED. SHALL SHEPFY ALL EQUIPMENT HAMPLATE DATA FOR WIRING AND OVER CURRENT PROTECTION REQUIREMENTS BEFORE PERFORMING PROJECT WITH STATE OF THE STATE OF TH

TYPE	SYMBOL	DESCRIPTION	VOLTS.		LAMP	MOUNTING	
HE	SIMBOL		70L13.	NO.	WATTS EA.	MODITING	
$\langle A \rangle$	æ	PENDANT — FORECAST FISHER ISLAND FIRE2—68, DEEP BRONZE SHADE: SAFARI FABRIC — GLASS: ETCH	120	1	20 MAX		
(B)	V V V	LIGHTOLIER 6001N (48° TRACK) D TRACK HEAD 22SS2WH	120	4	50 MAX		
(C)	0	RESTROOMS ONLY: 6" FLOURESCENT DOWNLIGHT JUNO LIGHTING #CSH-126/42T/241-CW	120	1	20 MAX		
0		SHOWER STALL ONLY: 6" FLOURESCENT DOWNLIGHT JUNO LIGHTING #CSH-126/42T/241-PW	120	1	20 MAX		
(E)	announce.	SUSPENDED OR FLUSH MOUNT: 2x4 FLOURESCENT LIGHT FIXTURE H BAY FIXTURE	120	2	60 MAX		
F		LAY-IN 2:2 FLOURESCENT FIXTURE LIGHTOUER XP 2 G VA 26U UNV HI	120	2	32 MAX		
(G)	-Ğ-	WALL SCONDE AT 66" A.F.F. FIXTURE BY OWNER	120	1	30 MAX		
	X	CEILING FAN EMFROFAN SILVER LINE 48F-9	120	1	75 MAX		
	A	LIGHTOLIER JETISVIEW EMERCENCY LIGHTING MRIS - BATTERY BACKUP					
	- 8	LICHTOLER ALMEN EXT SIGN					

NEW PANELBOARD SCHEDULE PANEL ID: PANEL B: 42 CKT PANEL TYPE: 1 LINE MOUNTING: RECESSED LOCATION: REAR HALLWAY ELECT. DATA: 120-240 30 4 WIRE 225 AMP MAINS: 200 AMP MLO WATT LOAD CIR. POLE TRIP WIRE COND. WATT LOA CIR. POLE TRIP WIRE COND. (AWC) (IN.) 'A' IDENTIFICATION IDENTIFICATION 'B' 'C' ВС 3/4 1200 1 20 12 3/4 1500 2 1 20 12 TREADMILL FANS 1 20 12 3/4 TREADMILL 4 1 20 12 3/4 FANS *** 3 1500 1 20 12 3/4 TREADMII I 6 1 20 12 3/4 1500 FANS 7 1 20 12 3/4 1500 TREADMILL 8 1 20 12 3/4 1200 FANS *** 9 1 20 12 3/4 TREADMILL 10 1 20 12 3/4 600 1500 FANS 1 20 12 3/4 TREADMILL LIGHTS (FRONT - 7) aee 11 1500 12 1 20 12 3/4 1260 *** 13 1 20 12 3/4 1500 TREADMILL 14 1 20 12 3/4 LIGHTS (MID - 6) *** 15 1 20 12 3/4 16 1 20 12 1500 TREADMILL 3/4 LIGHTS (REAR - 7) 1 20 12 3/4 *** 17 1500 TREADMILL 18 1 20 12 3/4 1080 LIGHTS (GROUP RM - 6) *** 19 1 20 12 3/4 1500 TREADMILL 20 1 20 12 3/4 1080 LIGHTS (OFF/HALL - 5) 1 20 12 3/4 TREADMILL 22 1 20 12 3/4 LIGHTS/FANS (R.R UTIL - 7) * *** 21 1500 1230 23 1 20 12 3/4 1500 TREADMILL 24 1 20 12 3/4 OUTLETS (OFF/MEM LOB) 1 20 12 3/4 1500 26 1 20 12 3/4 OUTLETS (R/R UTILI) *** 25 TREADMILL OUTLETS (5 FUNCT AREA & *** 28 1 20 12 3/4 27 1 20 12 3/4 TREADMILE 1500 1 20 12 3/4 OUTLETS (8 GROUP ROOM) *** ELIPTICALS 30 1 20 12 3/4 29 1500 1 20 12 3/4 ELIPTICALS 32 1 20 12 3/4 1080 OUTLETS (6 FREE WGTS) 1 20 12 3/4 TV'S GROUP ROOM FUNCT, AREA 33 34 1 20 12 3/4 OUTLETS (GUEST LOB/HALL) *** 1 20 12 3/4 **36** 1 20 12 35 1500 TV'S GROUP ROOM FUNCT, AREA 1200 OUTLETS (WATER FOUNT) 3/4 1 20 12 3/4 1800 R/R HAND DRYFRS 38 4800 DRYFR 1 20 12 3/4 SPARE 40 50 4800 1 20 12 3/4 42 4800 SPARE 10800 9150 9000 SUBTOTAL AMPS 11520 11790 13080 SUBTOTAL AMPS

A B C

17820 15720 19080

TOTAL DEMAND

65340W/360PH = 181.50 AMPS

A B C

22320 20940 22080

		-																		
					42 CI			PANEL									RECE:			
E	LECT	. DA	TA: _1	20-2	40 3ø	4 WIF	RE 400	O AMP MAINS:	40	20	AMP	MB			LOCA	TION:	REAR	HALLW	AY	
IR.	POLE	AMP C.B.	WIRE (AWC)	COND.		ATT LOA		IDENTIFICATION	F	PHAS		CIR.	POLE	AMP	WIRE (AWC)	COND.		WATT LOA		IDENTIFICATION
				-	'A'	'B'	'c'		A		3 C	No.	T OLL	C.B.	(AWC)	(IN.)	'A'	'8'	'c'	
1	3	20	12	1	800			ROOF TOP OUTLET	1	_	-	2	-				2880			OUTSIDE FASCIA SIGN
3	3	20	12	. 1		800		ROOF TOP OUTLET	Н	_		4	3	30	10	1"		2880		
5	- 3	20	12	1			800	ROOF TOP OUTLET	Ш	_	•	6	_						2880	
7	1	20	12	3/4	800			ROOF TOP OUTLET				8	1	20	12	3/4	-			SPARE
9	1	20	12	3/4		-		SPARE		-		10	1	20	12	3/4		-		SPARE
11	1	20	12	3/4			-	SPARE			•	12	1	20	12	3/4			-	SPARE
13					22320			SUBFEED PANEL B	1			14					5760			AHU UNIT #1
15	3	200	3/0	1		20220			П	•		16 3		60	4	1		5760		15.8KW HEAT STRIP
17							22080		П			18	1						5760	
19					2880			40GAL WATER HEATER				20					5760			AHU UNIT ∦2
21	3	30	10	1		2880						22	3	60	4	1		5760		15.8KW HEAT STRIP
23							2880		П			24	1						5760	
25					3840			5 TON A/C UNIT 1				26					3840			5 TON A/C UNIT 4
27	3	40	8	1		3840			IT		,	28	3	40	8	1		3840		
29							3840		IT			30	1						3840	
31					3840			5 TON A/C UNIT 2		*******		32					5760			AHU UNIT #3
33	3	40	8	1		3840		i	H		,	.34	- 3	60	4	1		5760		15.8KW HEAT STRIP
35							3840		H			36							5760	
37					3840			5 TON A/C UNIT 3			H	38	-		-		5760			AHU UNIT #4
39	.3	40	8	1		3840			1+	-		40	-	60	4	1	<u> </u>	5760		15.8KW HEAT STRIP
41						00.0	3840		H	-		42	-			ı ′			5760	
-			L	L	26800	24080	25700	SUBTOTAL AMPS	H		L	1 /2	-l		-		25920	25920	25920	SUBTOTAL AMPS

154400W/360PH = 428.88 AMPS ADJUSTED LISAGE LOAD В С 141050W/360PH = 391.81 AMPS 47680 46010 47360

ADJUSTED USAGE LOAD


CONNECTED LOAD DEMAND

** OCCUPANCY SENSORS REQUIRED FOR R/R'S & UTILITY ROOM LIGHTING & FANS *** 50% USAGE CALCULATED FOR TOTAL DEMAND LOAD

CLIENT: CAM AM VENTURES 9418 PRINCE HARRY DR. ORLANDO, FL 32836 PH 407-284-7979 SM THE STATES A TEVANT MIPROFEMENT FOR SCHEME ENGINEER OF RECORD AAA GATOR **ENGINEERING** CARLEBARONIETO FEB 1 2 2016 SCHERFR CONSTRUCTION & ENG ROY A. BROWN, P.E.
FLORIDA REGISTERATION #11649 CENTRAL C LORTDA DESIGNS I. ENGINEERING & BUILDING DESIGN CFD JOB NUMBER: 201602 SCALE: AS NOTED DATE: 01/XX/16
DESIGNED BY: UPO PLOT DATE: 01/XX/16 NDG CHECKED BY: RB 201602-ATF-6L ELECTRICAL

NOTES - SCHEDULES

SHEET NO:

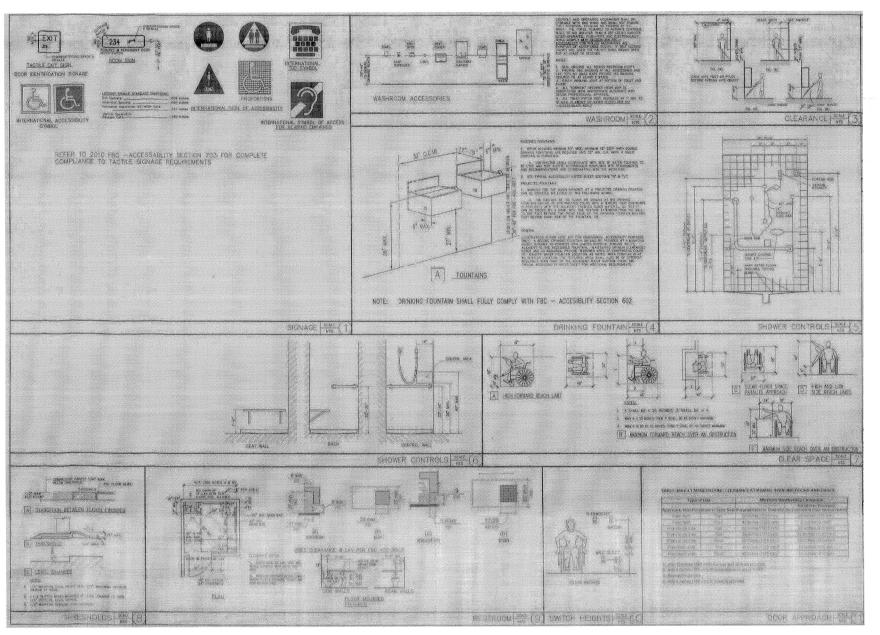

CAM AM VENTURES INTERNATIONAL, INC.

> 9418 PRINCE HARRY DR. ORLANDO, FL 32836 PH: 407-284-7979



N - 2 5 4 8 8 7 8 8 5 1 2 2 2

A TENANT WINDERDIT FOR

ENGINEER OF RECORD:

AAA GATOR
ENGINEERING

CA# 28430

SCANNED

SEE

FEB 12 200

SCHERER
FEB 1/2 20%
CONSTRUCTION & ENG

ROY A. BROWN, P.E.
FLORIDA REGISTERATION #11649

CENTRAL FLORIDA ESIGNS

460 NISHTHAWK DRIVE, LAKELAND, FL 2082 PHONE: (SKI) 644-2082; CELL 863-566-5594 E-MATL COPTIBLE JOSEPH SESSENPERZOONST CTYIL ENGINEERING & BUILDING DESIGN SE

201602

SCALE: AS NOTED DATE: 01/XX/16 PLOT DATE: 01/XX/16 DESIGNED BY: NDG DRAWN BY: NDG FILE NAME:

PRAWN BY: NDC
HECKED BY: RB
DRAWING TITLE:

ACCESSIBILITY
DETAILS

SHEET NO

HC.1

HVAC GENERAL NOTES:

- 1. ALL WORK TO BE DONE IN ACCORDANCE WITH THISSE PLANS AND THE LATEST VERSION OF THE 2014 FLORIDA BUILDING CODE.
 2. THESE BRAWNIGS ARE SCHEMARID IN MATURE AND ARE NOT INTENDED TO SHOW EVERY MINOR DETAIL. THE CONTRACTOR SHALL FIRST PROBLEMS OF THE CONTRACTOR SHALL FROM THE CONTRACTOR COMPLETE ACCEPTABLE WORKING INSTALLATION INSTALLATION COORDINATE THIS INSTALLATION WITH ALL TRADES.
 3. ALL WORK SHALL BE CHEPRORMED BY A LICENSED CONTRACTOR CERTIFIED IN THE STATE OF FLORIDA.
 4. THE CONTRACTOR SHALL WIST THE JOB SITE, MEET WITH ALL RELATED TRADES, AND FAMILIARIZE HIM/HER SELF WITH ANY ASSETTION OF THE CONTRACTOR SHALL WIST THE JOB SITE, MEET WITH ALL RELATED TRADES, AND FAMILIARIZE HIM/HER SELF WITH ANY ASSETTION OF THE CONTRACTOR SHALL BE SELF WITH ANY ASSETTION OF THE CONTRACTOR SHALL BE SELF WITH ANY ASSETTION OF THE CONTRACTOR SHALL BE PROVIDED FOR EQUIPMENT AND APPLIANCES CONTAINING EVAPORATOR COILS. CONDENSATE DISPOSAL SHALL BE PROVIDED FOR EQUIPMENT AND APPLIANCES CONTAINING EVAPORATOR COILS. CONDENSATE DISPOSAL SHALL BE CONTRACTOR OF THE COIL OF THE COIL OF THE CONTRACTOR OF THE COIL OF THE CONTRACTOR OF THE OFTEN OF THE OFTEN IN THE OFTEN OFTE

- BACKGRAFT DAMPER.

 3. INSTALL SMOKE DETECTORS (SD) AS PER SECTION MODE OF THE FBC, MECHANICAL.

 14. FIRE DAMPERS SHALL BE INSTALLE IN ACCORDANCE WITH CHAPTER 716 OF THE 2014 FBC.

 15. DUCTS AND TRANSFER OPENINGS THAT PENETRATE FIRE-RESISTANT RATED ASSEMBLES AND AREA NOT REQUIRED BY THIS SECTION TO HAVE DAMPERS SHALL COMPLY WITH THE REQUIREMENTS OF SECTION 712 OF THE 2014 FBC.

 16. COORDINATE DIFFUSER AND THERMOSTAT LOCATIONS WITH OWNER, CONTRACTOR, AND OTHER TRADES.

 17. ALL DUCTS AND FLENMIS SHALL BE MADE AIR TIGHT, CONSTRUCTED AND INSTALLED IN ACCORDANCE WITH THE CURRENT EDITION CHAPTER 13 OF THE FBC. DUCT LEAKAGE RATE SHALL NOT EXCEED 5% OF THE RATED AR HANDLER FLOW.

 18. ALTERNATE BRANDS OF EQUIPMENT MAY BE USED AS A SUBSTITUTION. THE ALTERNATE BRAND SHALL HAVE THE SAME SPISIBLE HEAT ARD AND SHALL NOT EXCEED THE TOTAL BRUIN CUTPOUT BY 10X.

HVAC EQUIPMENT SCHEDULE

SUMMER AMBIENT CONDITIONS 94/79 & DESIGN CRITERIA WINTER AMBIENT CONDITIONS 36/30 & DESIGN CRITERIA


MARK #	TC MBTUH	SC MBTUH	RSC MBTUH	TH MBTUH	SA CFM	OA CFM	SEER (EER)	MFG	ROOFTOP UNIT (EER)	WEIGHT	HEATER MODEL	POWER VOLT/PH	MCA (FLA)	HTR KW	NOTES:
RTU-1	61.75	53.03	40.55	68.3	2400	200	15.3	CARRIER	50HC-A06A2N5-0K1F0	679	PER MFG	208/230-3	64	15.8	2,3,4
RTU-1	61.75	53.03	40.55	68.3	2400	200	15.3	CARRIER	50HC-A06A2N5-0K1F0	679	PER	208/230-3	64	15.8	2,3,4
RTU-1	61.75	53.03	40.55	68.3	2400	200	15.3	CARRIER	50HC-A06A2N5-0K1F0	679	PER	208/230-3	64	15.8	2,3,4
RTU-1	61.75	53.03	40.55	68.3	2400	200	15.3	CARRIER	50HC-A06A2N5-0K1F0	679	PER	208/230-3	64	15.8	2,3,4

EACH MET SHALL MAKE A SOMEANT DECORRECT SHITTEN HALADEST TO THE CONTROLLED UNIX.

ANY PACTION PRINCIPAL ONCOSSORIES/PROBE SHALL DE COMMENDER DY THE HAVE CONTRACTOR PRIOR TO GRODNIN BASED ON STIT. CONSISTIONS AND REDUSTRY STAND.

4. OUTBOOK ART TO COCUMPAIT LOAD — BOOCHM OUTBOOK MAY/26 CALULALATED COCUMPAIT LOAD — 3.275M PER COCUMPAIT

ACTION. ARRIVER. DURING YES USED. COLUMPAIT BOUND. 35 3 2000 PER PERSON — TOOM TREADERD OUTSIDE AR INTAKE < BOOCHM PROMOCED OK

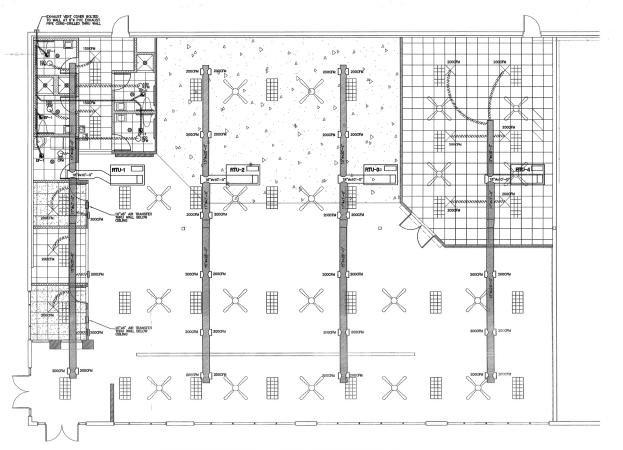

CLIENT: CAM AM VENTURES INTERNATIONAL, INC. 9418 PRINCE HARRY DR. ORLANDO, FL 32836 PH 407-284-7979 <u>isn</u> WANT IMPROVEMENT FOR: FOR SITE LOCATED AT LAKE RD. & SILVERLAKE P. ORANGE COUNTY, FLORIDA SCHEME AAA GATOR ENGINEERING CA# 28430 SCANNED FEB 1 2 28% SCHERER FEB 1 2 2016 CONSTRUCTION & ENG ROY A. BROWN, P.E.
FLORIDA REGISTERATION #11649
BRANNED NOT VALUE WEBSIGN RANGED SEAL AFFIRED



CFD JOB NUMBER: 201602

SCALE: AS NOTED DATE: 01/XX/16
DESIGNED BY: NDO OT DATE: 01/XX/16 DESIGNED BY:
NDG
DRAWN BY:
NDG
CHECKED BY:

DRAWING TITLE:

MECHANICAL PLAN SHEET NO:

M-1

REFLECTIVE CEILING and HVAC MODIFICATION PLAN

SCALE: 3/16" = 1'-0'

HVAC GENERAL NOTES:


- ALL WORK TO BE DONE IN ACCORDANCE WITH THESE PLANS AND THE LATEST VERSION OF THE 2014 FLORIDA BUILDING CODE. THESE DRAWINGS ARE SCHEMATIC IN NATURE AND ARE NOT INTENDED TO SHOW EVERY MINOR DETAIL. THE CONTRACTOR SHALL FURNISH AND INSTALL ALL ITEMS REQUIRED FOR A COMPLETE ACCEPTABLE WORKING INSTALLATION, AND COORDINATE THIS INSTALLATION WITH ALL TRADES.
- ALL WORK SHALL BE PERFORMED BY A LICENSED CONTRACTOR CERTIFIED IN THE STATE OF FLORIDA.
- THE CONTRACTOR SHALL VISIT THE JOB SITE, MEET WITH ALL RELATED TRADES, AND FAMILIARIZE HIM/HER SELF WITH ANY AND ALL CONDITIONS RELATING TO HIS/HER WORK
- ALL WORK SHALL BE COORDINATED WITH OTHER TRADES TO AVOID INTERFERENCE THAT MAY DELAY CONSTRUCTION.

 CONDENSATE DISPOSAL SHALL BE PROVIDED FOR EQUIPMENT AND APPLIANCES CONTAINING EVAPORATOR COILS. CONDENSATE DRAIN SYSTEM SHALL BE DESIGNED, CONSTRUCTED AND INSTALLED IN ACCORDANCE WITH SECTIONS 307.2.1 THROUGH 307.2.4 OF THE 2010 FLORIDA BUILDING CODE. CONDENSATE DRAIN SHALL TERMINATE TO APPROVED LOCATION.
- 7. ALL HORIZONTAL PRIMARY CONDENSATE DRAIN WITHIN UNCONDITIONED AREAS SHALL BE INSULATED TO PREVENT CONDENSATION FROM FORMING ON THE EXTERIOR OF THE DRAIN LINE.

 PACKAGED UNITS SHALL BE LOCATED ON ROOF WITH FACTORY ROOF CURB. ROOF CURB SHALL BE ATTACHED PER
- MANUFACTURER SPECIFICATIONS AND THE 2014 FBC.

 9. DUCT CONSTRUCTION AND INSTALLATION SHALL COMPLY WITH SECTION M603 OF THE FBC, MECHANICAL
- AIR CONDITIONING DUCT SYSTEM DESIGN BASED ON 1.5" TYPE "M" KNAUF DUCT AND R-6 INSULATED CLASS 1 SILVER FLEX DUCT, ALL DUCT WORK SHALL BE SEALED WITH SILVER TAPE.
- 11. KEEP ALL FRESH AIR INTAKES A MINIMUM OF 10' FROM EXHAUST FAN TERMINATION POINTS AND SANITARY SEWER VENT OUTLETS. PACKAGED UNIT SHALL INCORPORATE A MANUAL ADJUSTABLE FRESH AIR DAMPER ON ROOF TOP UNITS.
- VENT BATH FANS TO AN OUTSIDE VENT USING DUCT SIZE AS INDICATED. ALL EXHAUST FANS SHALL INCORPORATE A BACKDRAFT DAMPER.
- 13. INSTALL SMOKE DETECTORS (SD) AS PER SECTION M606 OF THE FBC, MECHANICAL
- 14. FIRE DAMPERS SHALL BE INSTALLED IN ACCORDANCE WITH CHAPTER 716 OF THE 2014 FBC.
 15. DUCTS AND TRANSFER OPENINGS THAT PENETRATE FIRE—RESISTANT RATED ASSEMBLIES AND AREA NOT REQUIRED BY THIS
- SECTION TO HAVE DAMPERS SHALL COMPLY WITH THE REQUIREMENTS OF SECTION 712 OF THE 2014 FBC.
- COORDINATE DIFFUSER AND THERMOSTAT LOCATIONS WITH OWNER, CONTRACTOR, AND OTHER TRADES.
 ALL DUCTS AND PLENUMS SHALL BE MADE AIR TIGHT, CONSTRUCTED AND INSTALLED IN ACCORDANCE WITH THE CURRENT
- EDITION CHAPTER 13 OF THE FBC. DUCT LEAKAGE RATE SHALL NOT EXCEED 5% OF THE RATED AIR HANDLER FLOW.


 18. ALTERNATE BRANDS OF EQUIPMENT MAY BE USED AS A SUBSTITUTION. THE ALTERNATE BRAND SHALL HAVE THE SAME SENSIBLE HEAT RATIO AND SHALL NOT EXCEED THE TOTAL BTUH OUTPUT BY 10%

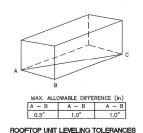


BATHROOM EXHAUST FANS:

MARK	BRAND	MOD.#	CFM	SP	VOLT	AMPS	MOUNT	QUANTITY
EF-1	PANASONIC	FV05VQ3	80	.25	120	0.13	CEILING	5

EF-1 TO BE WIRED TO LIGHT SWITCH

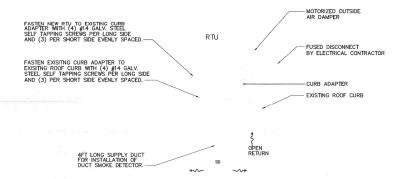

ROOFTOP PACKAGED UNIT MOUNTING DETIAL:

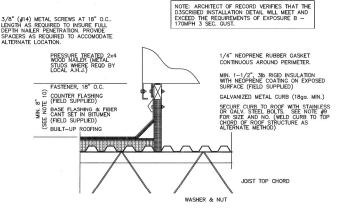

HVAC EQUIPMENT ROOF CURB DETAIL

ROOFTOP UNIT INSTALLATION NOTES:

- DUCT TRANSITION FROM RUT TO DUCT SIZE SHOWN ON MECH. FLOOR PLAN SHALL BE MADE BETWEEN RTU AND TOP OF ROOF WITHIN CURB.
- SIZE OF OPENING IN ROOF DECK TO BE AS SMALL AS POSSIBLE, 6" MAX. LARGER THAN DUCT SIZE SHOWN. COORDINATE W/STURCTURAL PLANS. INSTALL PER MANUFACTURER'S RECOMMENDATION AND INSTALLATION
- MANUAL. ALL WIRING BY ELECTRICAL CONTRACTOR.
- 4. SHIM CURB AS REQURIED TO PROVIDE HORIZONTAL INSTALLATION OF UNIT WITHIN PRESCRIPED TOLERANCES.
- CONTRACTOR SHALL COORDINATE LOCATION OF ROOF CURB WITH STURCTURE PRIOR TO INSTALLATION
- FRIOR TO INSTALLATION.

 6. ROOF CURB BY AIR CONDITIONER MANUFACTURERE. PROVIDE ADDITIONAL BRACING AND SUPPORT AS REQUIRED FOR ROOF CURB INSTALLATION TO WITHISTAND WIND LOAD PER LOCAL CODES.
- 7. CURB TO BE HEAVY GAUGE GALVANIZED STEEL CONTRCUTION AS RECOMMENDED BY MANUFACTURER, ALL FASTENERS SHALL BE CORROSION PROTECTED IF EXPOSED TO OUTDOORS. ANCHOR CURB TO STEEL BAR JOIST WITH 1/2" O THRU BOLT WITH LOCK
- CLEARANCE OF UNIT TO ABOVE FINISHED ROOF SHALL COMPLY WITH LOCAL CODE REQUIREMENTS

CLIENT: CAM AM VENTURES INTERNATIONAL, INC. 9418 PRINCE HARRY DR. ORLANDO, Fl., 32836 PH 407-284-7979



ENGINEER OF RECORD AAA GATOR ENGINEERING CA# 28430

> SCANNED FEB 1 2 2816

SCHERER FEB 1 2 2016

ROY A. BROWN, P.E. FLORIDA REGISTERATION #11649



IL ENGINEERING & BUILDING DESD


CFD JOB NUMBER 201602


SCALE: AS NOTED 01/XX/16 DESIGNED BY: DRAWN BY: CHECKED BY:

DRAYING TITLE: **HVAC** DETAILS + NOTES


M-2

SHEET NO

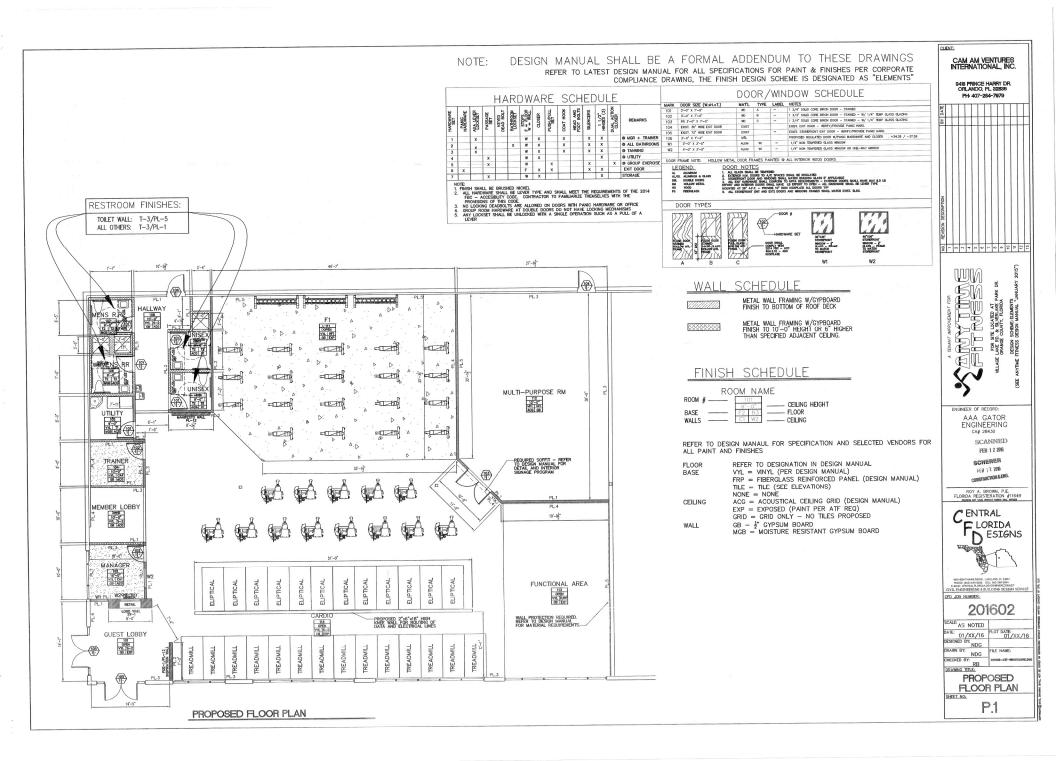


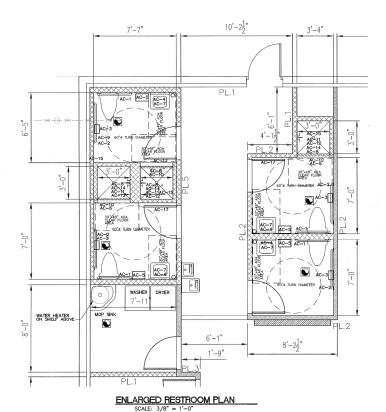

MARK	MANUFACTURER	NUMBER	DISCRIPTION
AC-1	BROBRICK	B 6606 SERIES	36" GRAB BAR
AC-2	BROBRICK	B 6606 SERIES	42" GRAB BAR
AC-3	BROBRICK	B 4288	TOILET TISSUE DISPENSOR
AC-4	BROBRICK	B 290 SERIES	18"x36" MIRROR
AC-5	WORLD DRYER	DA5-974	ELECTRIC HAND DRYER
AC-6	BROBRICK	B 6047 & B 204	SHOWER CURTAIN & ROD
AC-7	BROBRICK	B 4112	SOAP DISPENSOR
AC-8	DALTILE	BA765 BLACK	SHAMPOO SHELF
AC-9	BROBRICK	B 270	SANITARY NAPKIN DISPOSAL
AC-10	BROBRICK	B 6806 SERIES	GRAB BAR SHOWER
AC-11	-	-	SHOWER CONTORL - ADA
AC-12	ma .	-	SHOWER HEAD - ADA
AC-14	GEORGIA PACIFIC	53053	SOAP DISPENSOR SHOWER - SMOKE
AC-15	BROBRICK	B 5181	FOLDING SHOWER SEAT - OPTIONAL
AC-16	BROBRICK	B 6717	ROBE HOOK - STAINLESS STEEL
AC-17	BROBRICK	B 6727	DOUBLE ROBE HOOK - STAINLESS S

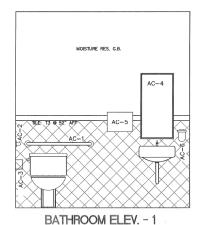



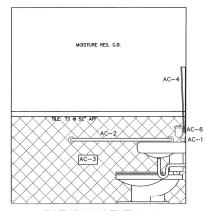

BATHROOM ELEV. - 2

CAM AM VENTURES INTERNATIONAL, INC. 9418 PRINCE HARRY DR. ORLANDO, FL. 32836 PH: 407-284-7979 W TEMPORENIE FOR CONTROL FOR CON JJQ ' ENGINEER OF RECORD: AAA GATOR ENGINEERING CA# 28430 SCANNED FEB 1 2 28% SCHERER FEB 1 2 7006 FLORIDA REGISTERATION #11649 CENTRAL FLORIDA ESIGNS CFD JOB NUMBER: 201602 SCALE: AS NOTED DATE: 01/XX/16 PLOT DATE: 01/XX/16 DESIGNED BY: DRAWN BY: DRAWN BY: NDG
CHECKED BY: RB
DRAWING TITLE: ENLARGED R/R PLAN / ELEVATIONS

CLIENT:

WALL TYPE GENERAL NOTES:

- 1. FLOOR AND CERLING RUNNERS (NOT SHOWN). CHANNEL SHAPED RUNNERS, 3—½" WIDE (UNIV.) 1—½" (EGS, FORMED FROM MIN. no. 25 MSG GALV. STEEL ATTACHED TO FLOOR AND CERLING WITH PASTREESS, SPACED 24 N. MAKE ED. 25 MSG GALV. STEEL SHARED SHOWN THE PASTREESS, SPACED 24 N. MAKE ED. 25 MSG GALV. STEEL SHARED 24 N. O. CONTRE MAKE ST. (SPACED AS MIN. 10. 25 MSG GALV. STEEL SHARED 24 N. O. CONTRE MAKE ST. (SPACED) AND MIN AD ALTO CONTREME SHARED S
- LB/FTS. U.S. GREENHERE ILC, COCOON STABILIZED OR COCOON—FM (FREE RATED MARTINA TO BATS AND BAMCHEST (DTM 3) AND SAME AND AND SAME AND SAME

AMERICAN GYPSUM CO. TYPES AG-C, AGX-1

BEUING NEW BUILDING MATERIALS PUBLIC LET. CO. TYPE DBX-1

BPB AMERICA INC. TYPES 1, EGRG, PROROC TYPE X, PROROC TYPE C

BPB CANADA, INC. PROROC TYPE C, PROROC TYPE X OR PROROC TYPE ABUSE-RESISTANT.

CANADIAN GYPSUM COMPANY, TYPES AR, C, IP-AR, EP-X1, IPC-AR, SCX, SHX, WRC, OR WRX.

G-P GYPSUM CORP. SUB OF GEORGIA-PACIFIC CORP. TYPES 5, 9, C, DAP, DD. DA. DGG. DS. GPFS6.

LAFARGE NORTH AMERICA INC. TYPES LGFC2, LGFC2A, LGFC6, LGFC6A, ILGFC-C, LGFC-C/A.

NATIONAL GYPSUM CO. TYPES FSK, FSK-C, FSK-G, IFSW, FSW,3, FSW-5

PABCO BUILDING PRODUCTS, LLC, DBA:

PABCO GYPSUM. TYPE PG-C OR PG-9

PANEL REY S.A. TYPE PRX.

SIAM BYPSUM INDUSTRY (S.A.R.A.BURI) CO. LTD. TYPE EX-1

TEMPLE—INLAND FOREST PRODUCTS COPR. TYPE X, VENEER PLASTER BASE TYPE X, WATER RATED TYPE X, SHEATHING — TYPE X, SOFFIT — TYPE X.

UNITED STATES GYPSUM CO. TYPE AR, C, FRX-G, IP-AR, IP-X1, IP-X2 IPC-AR, SCX, SHX, WRC OR WRX.

USG MEXICO S IDE C V. TYPE AR, C, IP-AR, IP-X1, IP-X2, IPC-AR, SCX, SHX, WRC OR WRX.

4A. OYPSUM BOARD (AS ALTERNATE TO ITEM 4) NOM % THICK CYPSUM PANELS WITH EXCLED, SOLARE OR TAPERDE DEDSES, APPLIED VERVICALLY OR CONTROL OF THE ACTION OF TH

CANDIAN GYPSUM COMPANY; THPES AR, C, IP-AR, IP-X1, IP-X2, IPC-AR, SCX, SHX, WRC OR WRX.

UNITED STATES GYPSUM CO; THYPE AR, C, FRX-G, IP-AR, IP-X1, IP-X2 IPC-AR, SCX, SHX, WRC OR WRX.

USG MEXICO S A DE CV; TYPE AR, C, IP-AR, IP-X1, IP-X2, IPC-AR, SCX, SHX, WRC OR WRX.

 GYPSUM BOARD (AS AN ALTERNATE TO ITEMS 4 OR 4A); NOM ¾" THICK, 4 FT. WIDE, INSTALLED AS DESCRIBED IN ITEM 4A, WITH SCREW LENGHT INCREASED TO 1-1/4". CANADIAN GYPSUM COMPANY; TYPES AR, IP-AR.

USG MEXICO S A DE C W: TYPES AR- IP-AR

- USE MERIOO S A DE C. W. TYPES AR-P-AR

 5. HON'T TOKE AND COMPOSING. BY ON PRESIDED JOINT COLUMPICAND, APPLIED

 5. HON'T TOKE AND COMPOSING. BY ON PROPERT PARK 2. BILL WIDE

 DIRECTION IN HIST LAYER OF COMPOSING WAY PREST THAT 2. BILL WIDE


 DIRECTION HIST LAYER OF COMPOSING WAY BE APPLIED TO THE

 ARTERISATE, NORMAL 3½. THICK OPPSINJ PLASTER MAY BE APPLIED TO THE


 DITTIES SIMPLED WITH SOLURE EDGES.

 ARE SIMPLED WI
- TYPE RSIC-1.

 7. WALL AND PARTITION FACING AND ACCESSORIES (OPTIONAL NOT SHOWN);

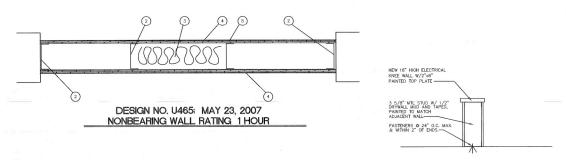

FREE STANDING KNEE WALL DETAIL

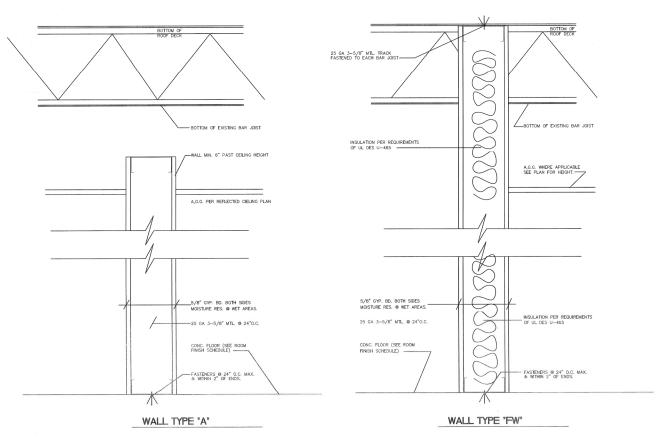

PROPOSED 1 HOUR FIRE WALL "FW"

CLIENT: CAM AM VENTURES INTERNATIONAL, INC. 9418 PRINCE HARRY DR. ORLANDO, FL. 32836





ENGINEER OF RECORD AAA GATOR ENGINEERING CA# 28430 SCANNED FFB 1 2 2016



ROY A. BROWN, P.E.
FLORIDA REGISTERATION #11649
DRIVEN SET VILLO WITHOUT RIGIDS SEAL APPROVE




CFD JOB NUMBER: 201602

SCALE: AS NOTED DATE: 01/XX/16 DESIGNED BY: 01/XX/16 NDG DRAWN BY:

CHECKED BY: CHECKED BY:
RB
DRAWING TITLE:

WALL TYPES

P.3

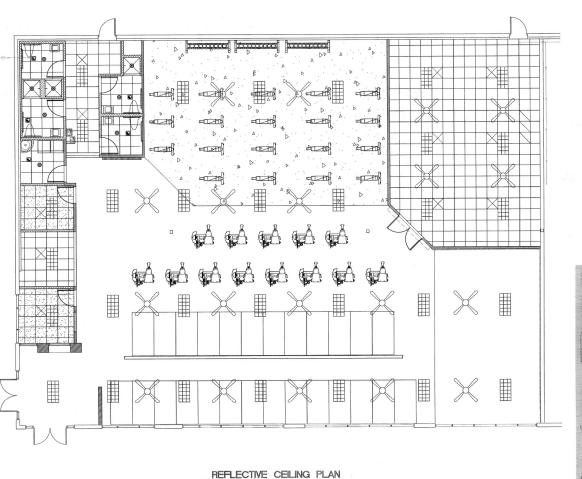


SCALE: 3/16" = 1'-0'


HANGE WRES SHALL BE FIZ GAUGE HANGE WRES SHALL BE FROMED FOR ALL WAN RUNGERS AND CROSS AUGLES WITH 8* DELING PROJECTION BONDERRS WRES THAT ARE MORE THAN IT OUT OF RUNB SHALL HAVE COUNTERPRACED WRES HID MAY BE ATTACHED TO TWO ADJACENT WALLS. THE COUNTS MUST BE AT LEAST HER WALLS.

WERS OVER 12' LONG AND ALL MAN RANNERS NOT CONNECTED TO WALLS MUST C'ED NEAR THE FREE EMD MITH A M. (2. STM.) SCENELY ATTACHED TO PREVENT 4 BRY WITE SHALL BE PROMIDED AT 12" DE STATISME AT 4" FROM ANY WALL MEETS OFFILL BE THAT WYSELF ALL BEST OFFILL BE THAT WYSELF ALL BEST OFFI THANKS SELVE WITE THE THANKS SELVE WITE STATISMEN SELVE WITE BEST OFFICE AND ANY WALL BEST OFFI THANKS SELVE WITE TAYLUR BEGG!

THE DAMES OF BELL STORY OF THE COURT ABOVE.

OUR STOLL OF BE FASTINGD TO MANS MUNICE AND EXTED (AND FASTIN) TO
ALL STOLL OF BE FASTINGD TO MANS MUNICE AND EXTED (AND FASTIN) TO
ALL STOLLARS SUPPORT MAN THE SOOT ABOVE. THE SHALL BE ALCOURT TO
THE WASTER AND EXCORMENT MAN, DEF PRESENCE WASTER THE SOTT BANK TOWN TO SHALL BE FASTING TO THE MEN A SET TOWN THE REST. BANK WHAT.

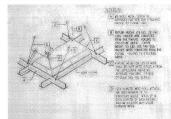

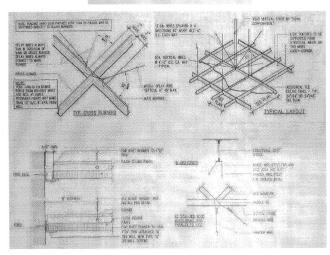

SUSPENDED CEILING DETAILS SCALE! NTS

CAM AM VENTURES

9418 PRINCE HARRY DR. ORLANDO, FL 32836 PH: 407-284-7979

SM EL.

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ENGINEER OF RECORD: ENGINEERING CA# 28430

SCANNED

FEB 1 2 2016

SCHERER FEB 1 2 2015

CONSTRUCTION & FING
ROY A. BROWN, P.E.
FLORIDA REGISTERATION #11649
BROWN ROY VALO WHIND SUL AFFIND

ENTRAL FLORIDA DESIGNS

440 NEGHTHAWK DREVE, LARELAND, FL 33813 PHOND: (843) 644-5838: CELL 663-350-5904 E-MAIL: CENTRALFLOREDA DESERVIVERIZONIOS VII. ENGINEERING & BUILDING DESIGN


CFD JOB NUMBER:

201602

SCALE: AS NOTED DATE: 01/XX/16
DESIGNED BY: NDG
DRAWN BY: NDG
CHECKED BY: DB PLOT DATE: 01/XX/16 RB DRAWING TITLE:

REFLECTIVE **CEILING PLAN**

P.4

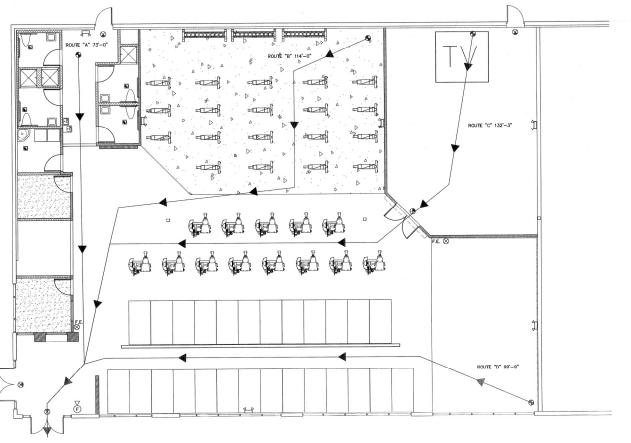

NOTES:
FE = PROVIDE ONE CERTIFIED 3A-40-BC
FIRE EXTINGUISHER FOR EACH 3000 SQ.FT.
AND WITH A MAXIMUM TRAVEL DISTANCE TO
REACH OF 75. TOP NOT TO EXCEED 5'
ABOVE THE FLOOR.

EACH EMERGENCY LIGHT SHALL BE TIED TO LIGHTING CURCUIT IN SAME ROOM OR AREA AS LOCATION OF FIXTURE PER NEC-700-12. EMERGENCY LIGHTS SHALL HAVE BATTERY BACKUP AND FLUSH MOUNTED.

SYMBO	DL LEGEND						
SYMBOL	DESCRIPTION						
ROUTE "A" 120'-0"	DIRECTION OF EXIT WITH DISTANCE						
₽d	FIRE ALARM WITH HORN						
€	EXIT LIGHT WITH BATTERY BACKUP						
	EMERGENCY LIGHTS WITH BATTERY BACKUP						
F.E. ⊗	FIRE EXTINGUISHER IN CABINET						

FIRE DOOR CAPACITY (NOT OCC CALC)

SEE NOTE #4 - SITE SPECIFIC NOTES

DOOR # 1 (72" DOUBLE DOOR) 68"/0.2 = 340 OCCUPANTS

DOOR # 2 (72" DOUBLE DOOR)

68"/0.2 = 340 OCCUPANTS

DOOR # 3 (36" SINGLE DOOR)

34"/0.2 = 170 OCCUPANTS

DOOR # 4 (36" SINGLE DOOR) 34"/0.2 = 170 OCCUPANTS

FIRE CAPACITY = 1020 OCCUPANTS (NOT OCC. CALC) NEW CAPACITY = 216 OCCUPANTS (PROPOSED)

CAM AM VENTURES INTERNATIONAL, INC.

9418 PRINCE HARRY DR. ORLANDO, FL 32836 PH: 407-284-7979





AAA GATOR ENGINEERING SCANNED FEB 1 2 2016

> SCHERER FEB 1 2 20%

CONSTRUCTION & ENG. ROY A, BROWN, P.E.
FLORIDA REGISTERATION #11649

CENTRAL FLORIDA ESIGNS

460 NEGHTHAWK DREVE, LAKELAND, FL 33813 PHONE: (843) 644-5838; CELL-863-358-5894 E-MAEL: CENTRAL PLOREDA DESERVEVERIZON IVIL ENGINEERING & BUILDING DESI CFD JOB NUMBER:

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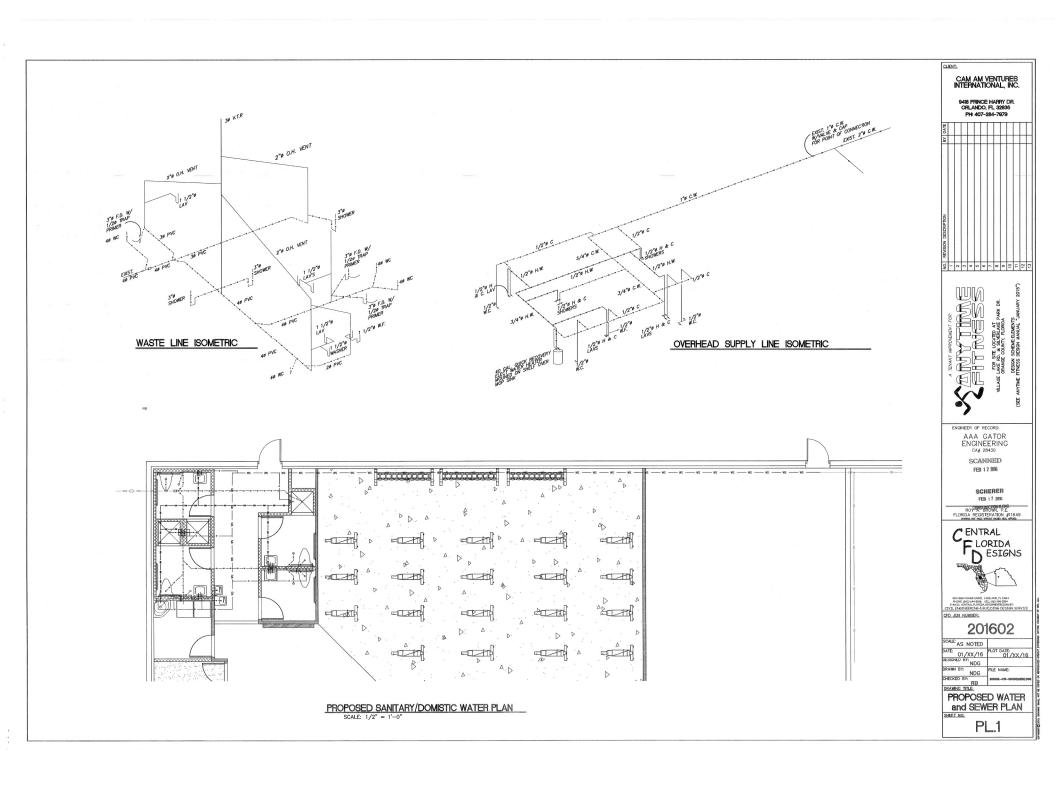
SCALE: AS NOTED

LIFE SAFETY PLAN

P.5

LIFE SAFETY PLAN

SCALE: 1/8" = 1'-0"





- FOR SI: 1 GALLON = 3.785L, 1 GALLON PER MINUTE = 3.785L/MIN.: 1 POUND PER SQUARE INCH = 6.895 KPS
- : A HAND HELD SHOWER SPRAY IS A SHOWER HEAD. CONSIMPION TOLERANCES SHALL BE DETERMINED FROM REFERENCED STANDARDS.
- WATER FACTOR IN GALLONS PER CYCLE PER CUBIC FOOT.

- GENERAL NOTES: DO NOT SCALE DRAWINGS FOR PARTITION LOCATION. CONSULT ARCHITECTURAL & STRUCTURAL DRAWINGS FOR DIMENSIONS.
- CONTRACTOR SHALL VISIT SITE TO VERIFY FIELD CONDITIONS AND PHYSICAL LOCATIONS AND SIZE OF EXISTING SERVICES.
- 3. SANITARY LINES LARGER THAN 2-1/2" TO SLOPE 1/6" PER FOOT
- SANITARY LINE 2-½" AND LESS TO SLOPE ¼" PER FOOT.
- CONSULT ARCHITECTURAL DRAWINGS FOR ALL FINISH FLOOR AND GRADE ELEVATIONS.
- 6. SEE ARCHITECTURAL DRAWINGS FOR ROOF DRAINAGE.

FLOW RATES FOR ALL FIXTURES SHALL BE IN COMPLIANCE WITH FBC TBL 604.4 AS INDICATED ABOVE

FIXTURE SCHEDULE

SELECTION BASED ON ZURN MANU	FACTUR	ING SH	OKSTOP DA	TA:			
EQUIPMENT SELECTION BASED ON:	SYSS	TEM CO	ONNECTIONS	:			
ITEM DESCRIPTION	CW	HW	TRAP	DRAIN	FIX. UNITS	MFGR.	MODEL
WATER CLOSET (1.6 GAL/FL)	1/2"		INTERNAL	3°	4	PROFLO	WHITE - PF2203 - ADA, (TANK PF3212) (SEAT PFTSC0F200WH)
	+						SEAT SHALL BE OPEN - FRONT TYPE PER FBC - PLUMB 420.3
LAVATORY (ADA)	1/2*	1/2"	1-1/2"	2"	1	PROFLO	PF5504WH - ADA COMPLIANT (FAUCET NOWEN - 8800 ADA)
DRINKING FOUNTAIN	1/2*		1-1/4"		.5	PROFLO	EZSITLBLC - ADA COMPLIANT
SHOWER VALVE	1/2"	1/2"			2	MOEN	62300 - ADA COMPLIANT
SHOWER VALVE TRIM	1					MOEN	TL182 - ADA COMPLIANT
MOP SINK (SERVICE)	1/2"	1/2"	1-1/2"	2"	2	PROFLO	PFZ199825 (FAUCET MOEN 8230 ADA COMPLIANT)
FLOOR DRAIN	+					PROFILO	3.5" SOCKET W/8" GRATE - PF42847 - STAINLESS
TRAP PRIMER	\top					PROFLO	PFPR500 TRAP PRIMER VALVE
WATER HEATER	+					PEXAN	E56 50 DCRS 50 GALLON SHORT MODEL

PLUMBING FIXTURES SHOWN OR EQUAL SHALL BE PROWDED BY CONTRACTOR WITH SHOP DRAWINGS ON EACH FIXTURE SUBMITTED FOR APPROAL BY THE OWNER AND DESIGNER. FIXTURE COLOR IS WHITE.

IMPORTANT - ALL FIXTURES SHALL MEET OR BE ADA COMPLIANT AND MOUNTED AT HEIGHTS ACCORDING TO 2010 FBC - ACC

MATERIAL SPECIFICATIONS

- DOMESTIC WATER PIPING SHALL BE HARD COPPER PIPE TYPE "L" ANSI / ASTM B-BB WITH WROGHT-COPPER SOLDER-JOINT FITTIN ASTM B-1622. BELOW GRADE PIPING SHALL BE TYPE "K" ANSI ASTM SOFT COPPER WITH NO JOINTS OR FITTINGS BELOW GRADE.
- 2. PIPING: SOIL, WASTE AND VENT PIPING SHALL BE PVC.
- INSULATE ALL HOT WATER LINES AS FOLLOWS: HW SUPPLY 1" THIC PERFORMED ARWAFLEX PIPE INSULATION, HORIZONTAL STORM DRAIN PIPING WITH 1-½" THICK PERFORMED FIBERGLASS PIPE INSULATION.


SIZE (INCHES)	MINIMUM SLOPE (INCH PER FOOT)
2-1/2" OR LESS	1/4"
3" TO 6"	1/8"
8" OR LARGER	1/16"

NOTE: IT SHALL BE ACCEPTABLE TO USE CPVE FOR WATER LINES

	MAIN WATER SHUT OFF VALVE AND PRESSURE REGULATOR.
	EXPANSION TANK
COLD WATER SUPPLY	TO REMAINING COLD WATER FIXTURES
HOT WATER SUPPLY	SHUT OFF VALVE
DIELECTRIC UNION	PRESSURE RELIEF VALVE
	WATER HEATER PER SPECIFICATIONS
1/2" DRAIN TO OUTSIDE	-METAL DRAIN PAN
g y a r wa wa wa w	12" HIGH WOOD FRAMED PLATFORM ON SHI PROVIDE HIGHT SO THAT PAN DRAIN CAN 1/4" FER 12" OUTSEC OF BUILDING
WATER	HEATER SHALL COMPLY W/2014 FBC - PLUMBING

WATER HEATER DETAIL



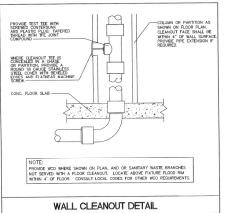

GENERAL SPECIFICATIONS ALL WORK SHALL BE PERFORMED BY A LICENSED CONTRACTOR IN A FIRST CLASS WORKMAN LIKE MANNER. SAID CONTRACTOR SHALL MEET GOVERNING AUTHORITIES.

- IT SHALL BE THE RESPONSIBILITY OF THE CONTRACTOR TO PROVIDE ALL LABOR, MATERIALS AND SUPERVISION NECESSARY TO ACCOMPLISH THE WORK SHOWN AND/OR NOTED ON THE DRAWINGS.
- ALL REQUIRED INSURANCE SHALL BE PROVIDED FOR PROTECTION AGAINS PUBLIC LIABILITY AND PROPERTY DAMAGE FOR TRHE DURATION OF THE WORK.
- CONTRACTOR SHALL VISIT THE JOB SITE PRIOR TO BID AND VERI ALL CONDITIONS, LOCATIONS, DIMENSIONS AND COUNT AS SHOWN OR NOTED ON THE DRAWMINGS. THIS SHALL INCLUDE ANY AND FRABRICATIONS REQUIRED PRIOR TO INSTALLATION.
- IT SHALL BE THE RESPONSIBILITY OF THE CONTRACTOR FOR THE ADVANCED ORDERING OF LONG LEAD ITEMS AS NOT TO INTERFER WITH THE PRODUCTION OF OTHER TRADES RESULTING IN ANY DOWN OR LAG TIME.
- CONTRACTOR SHALL GUARANTEE ALL MATERIALS AND WORKMANSHI FREE FROM DEFECTS FOR A PERIOD OF NOT LESS THAN (1) ONE YEAR FROM DATE OF ACCEPTANCE, UNLESS INDICATED OR SPECIFIED OTHERWISE.
- THE CONTRACTOR SHALL BE RESPONSIBLE TO REPAIR TO ORIGINAL CONDITION ANY AND ALL DAMAGES TO BUILDING SURFACES, EQUIPMENT, AND FURNISHING CAUSED DURING PERFORMANCE OF WORK.
- 10. LOCATION OF PLUMBING ROUGH—IN MAY CHANGE. VERIFY EXACT LOCATION WITH ARCHITECT/ENGINEER PRIOR TO INSTALLATION. DRAWINGS ARE DIAGRAMATIC. DO NOT SCALE FOR THE EXACT LOCATION OF FIXTURES, PIPING, EQUIPMENT, ETC.
- ALL MATERIALS SHALL BE NEW AND SHALL BEAR UNDERWRITERS LABEL WHERE APPLICABLE.
- THE COMPLETED SYSTEM SHALL BE FULLY UPERATIVE AND ACCEPTANCE BY THE ARCHITECT/ENGINEER MUST BE A CONDITON OF THE CONTRACT.
- ALL EXCAVATION AND BACKFILL AS REQUIRED FOR THIS PHASE OF CONSTRUCTION SHALL BE A PART OF THIS CONTRACT.
- 14. CONTRACTOR SHALL PAY FOR ALL PERMITS, FEE, INSPECTIONS, AND TESTINGS.
- 15. ARCHITECTURAL AND/OR ENGINEERING EXPENSES HTAT ARE INCURRED DUE DUE TO REMSIONS OR SUBSTITUTIONS REQUESTED BY THE CONTRACTOR SHALL BE PAID FOR BY THAT CONTRACTOR.
- THE CONTRACTOR SHALL FURNISH ALL WATER METERS UNLESS OTHERWISE NOTED.
- ALL WORK SHALL BE COORDINATED WITH OTHER TRADES TO AVOID INTERFERENCE WITH THE PROGRESS OF CONSTRUCTION.
- VERFY LOCATION, SIZE, ELEVATION, MATERIALS AND PRESENT STATE OF ALL EXISTING UTILITIES.
- INSTALL READLY ACCESSIBLE GATE VALVES IN ALL BRANCH WATER LINES SERVING ANY ROOM HAVING PLUMBING FIXTURES. ALL FIXTURES SHALL BE PROVIDED WITH READLY ACCESSIBLE VALVES.
- 20. MAIN WATER SUPPLY SHALL BE EQUIPTED WITH A BACKFLOW PREVENTER.
- 21. ALL THREADED WATER OUTLETS (EXCEPT FOR AUTOMATIC CLOTHES WASHERS) SHALL BE FURNISHED WITH WATTS #9A APPROVED VACCUM BREAKERS.
- FUNISH AND INSTALL APPROVED WATER HAMMER ARRESTORS ON QUICK CLOSING VALVES NEAR THE FIXTURES IN AN EFFECTIVE RANGE.
- 23. WHERE DISSIMULAR METALS ARE TO BE JOINED, APPROVED INSULATION UNIONS SHALL BE USED.
- 25. IF THE CONTRACTOR PROPOSED TO USE ANY ARTICLE DEVICE, PRODUCT, OR MATERIALS WHICH IS NOT SPECIFIED. THE CONTRACTOR SHALL BE RESPONSIBLE TO PROVE TO THE ARCHITEC/ENGINEER THAT THE PROPOSED SUBSTITUTION IS EQUAL.
- 26. THE CONTRACTOR SHALL KEEP ALL AREAS IN WHICH WORK IS BEING PERFORMED, FREE FROM DEBRIS AT ALL TIMES AND SAID AREAS SHALL BE LEFT BROOM CLEAN AT THE END OF EACH WORKING DAY.
- THE CONTRACTOR SHALL FURNISH A COMPLETE SET OF AS-BUILT DRAWINGS SHOWNING ALL CHANGES AND DEVIATION, TO THE ARCHITEC/ ENGINEER PRIOR TO COMPLETION OF THE PROJECT.

WATER HAMMER ARRESTOR - PIPING SCHEDULE SELECTION BASED ON ZURN MANUFACTURING SHOKSTOP DATA MFG. CAT. TYPE NO. SYSTEM 12 - 32 33 - 60 60 - 113 FIXTURE 88 F.U. 256 F.U. 490 F.U. 904 F.U. NOTES: ** SYMBOL Z-1700 NOTES: ** CONTRACTOR SHALL PROVIDE AND INSTALL WATER HAMMER ARRESTORS IN DOMESTIC PIPING SYSTEM AS PER 2010 FAC AND PER MANUFACTURES RECOMMENDATIONS.

CLIENT: CAM AM VENTURES INTERNATIONAL, INC.

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SM 11 FOR FOR SITE LOCATED AT LAKE RD. & SLVERLAKE P ORANGE COUNTY, FLORIDA SCHEVE TENANT IN · DD

> ENGINEER OF RECORDS AAA GATOR ENGINEERING CA# 28430

SCANNED FEB 1 2 20%

SCHERER

FEB 1 2 2016 CONSTRUCTION & ROY A. BROWN, P.E. FLORIDA REGISTERATION #11649



CFD JOB NUMBER:

SHEET NO:

201602

SCALE: AS NOTED DATE: 01/XX/16 PLOT DATE: 01/XX/16 DESIGNED BY: 100 DRAWN BY: CHECKED BY: FILE NAME:

DRAWING TITLE: PLUMBING NOTES/DETAILS